ADDENDUM #5 - MARCH 4, 2024

RE: North Bay Fire Station

Seismic Upgrade and Addition

Project #21.59

FROM: HGE ARCHITECTS, Inc.

333 South 4th Street

Coos Bay, Oregon 97420

541-269-1166

TO: Prospective Bidders

This Addendum forms a part of the Contract Documents and modifies the original Documents dated January 2024, as noted below. Acknowledge receipt of this Addendum in the space provided on the Bid Form. Failure to do so may subject Bidder to disqualification.

This Addendum consists of **ONE (1)** page(s) together with the following attachments:

- REVISED Sheet S2.1 Structural Roof Framing Plan
- REVISED Sheet S7.2 Structural Wood Framing Detail

CHANGES TO PROJECT MANUAL:


1. Section 00-1000 Summary, Paragraph 1.05, A: ADD "Contractor to maintain one (1) apparatus bay open, full width and depth, at all times during construction for Owner's operation."

CHANGES TO DRAWINGS:

- 1. Sheet S2.1, Footing at Grid 1: Make the following notes:
 - **a.** A cold joint is acceptable for a 2-pour installation. Contractor to submit a joint location for review prior to construction.
 - **b.** See attached structural sheets S2.2 and S7.2 with added information for top of wall to roof connection.

SUBSTITUTION APPROVALS: None.

END OF ADDENDUM #5

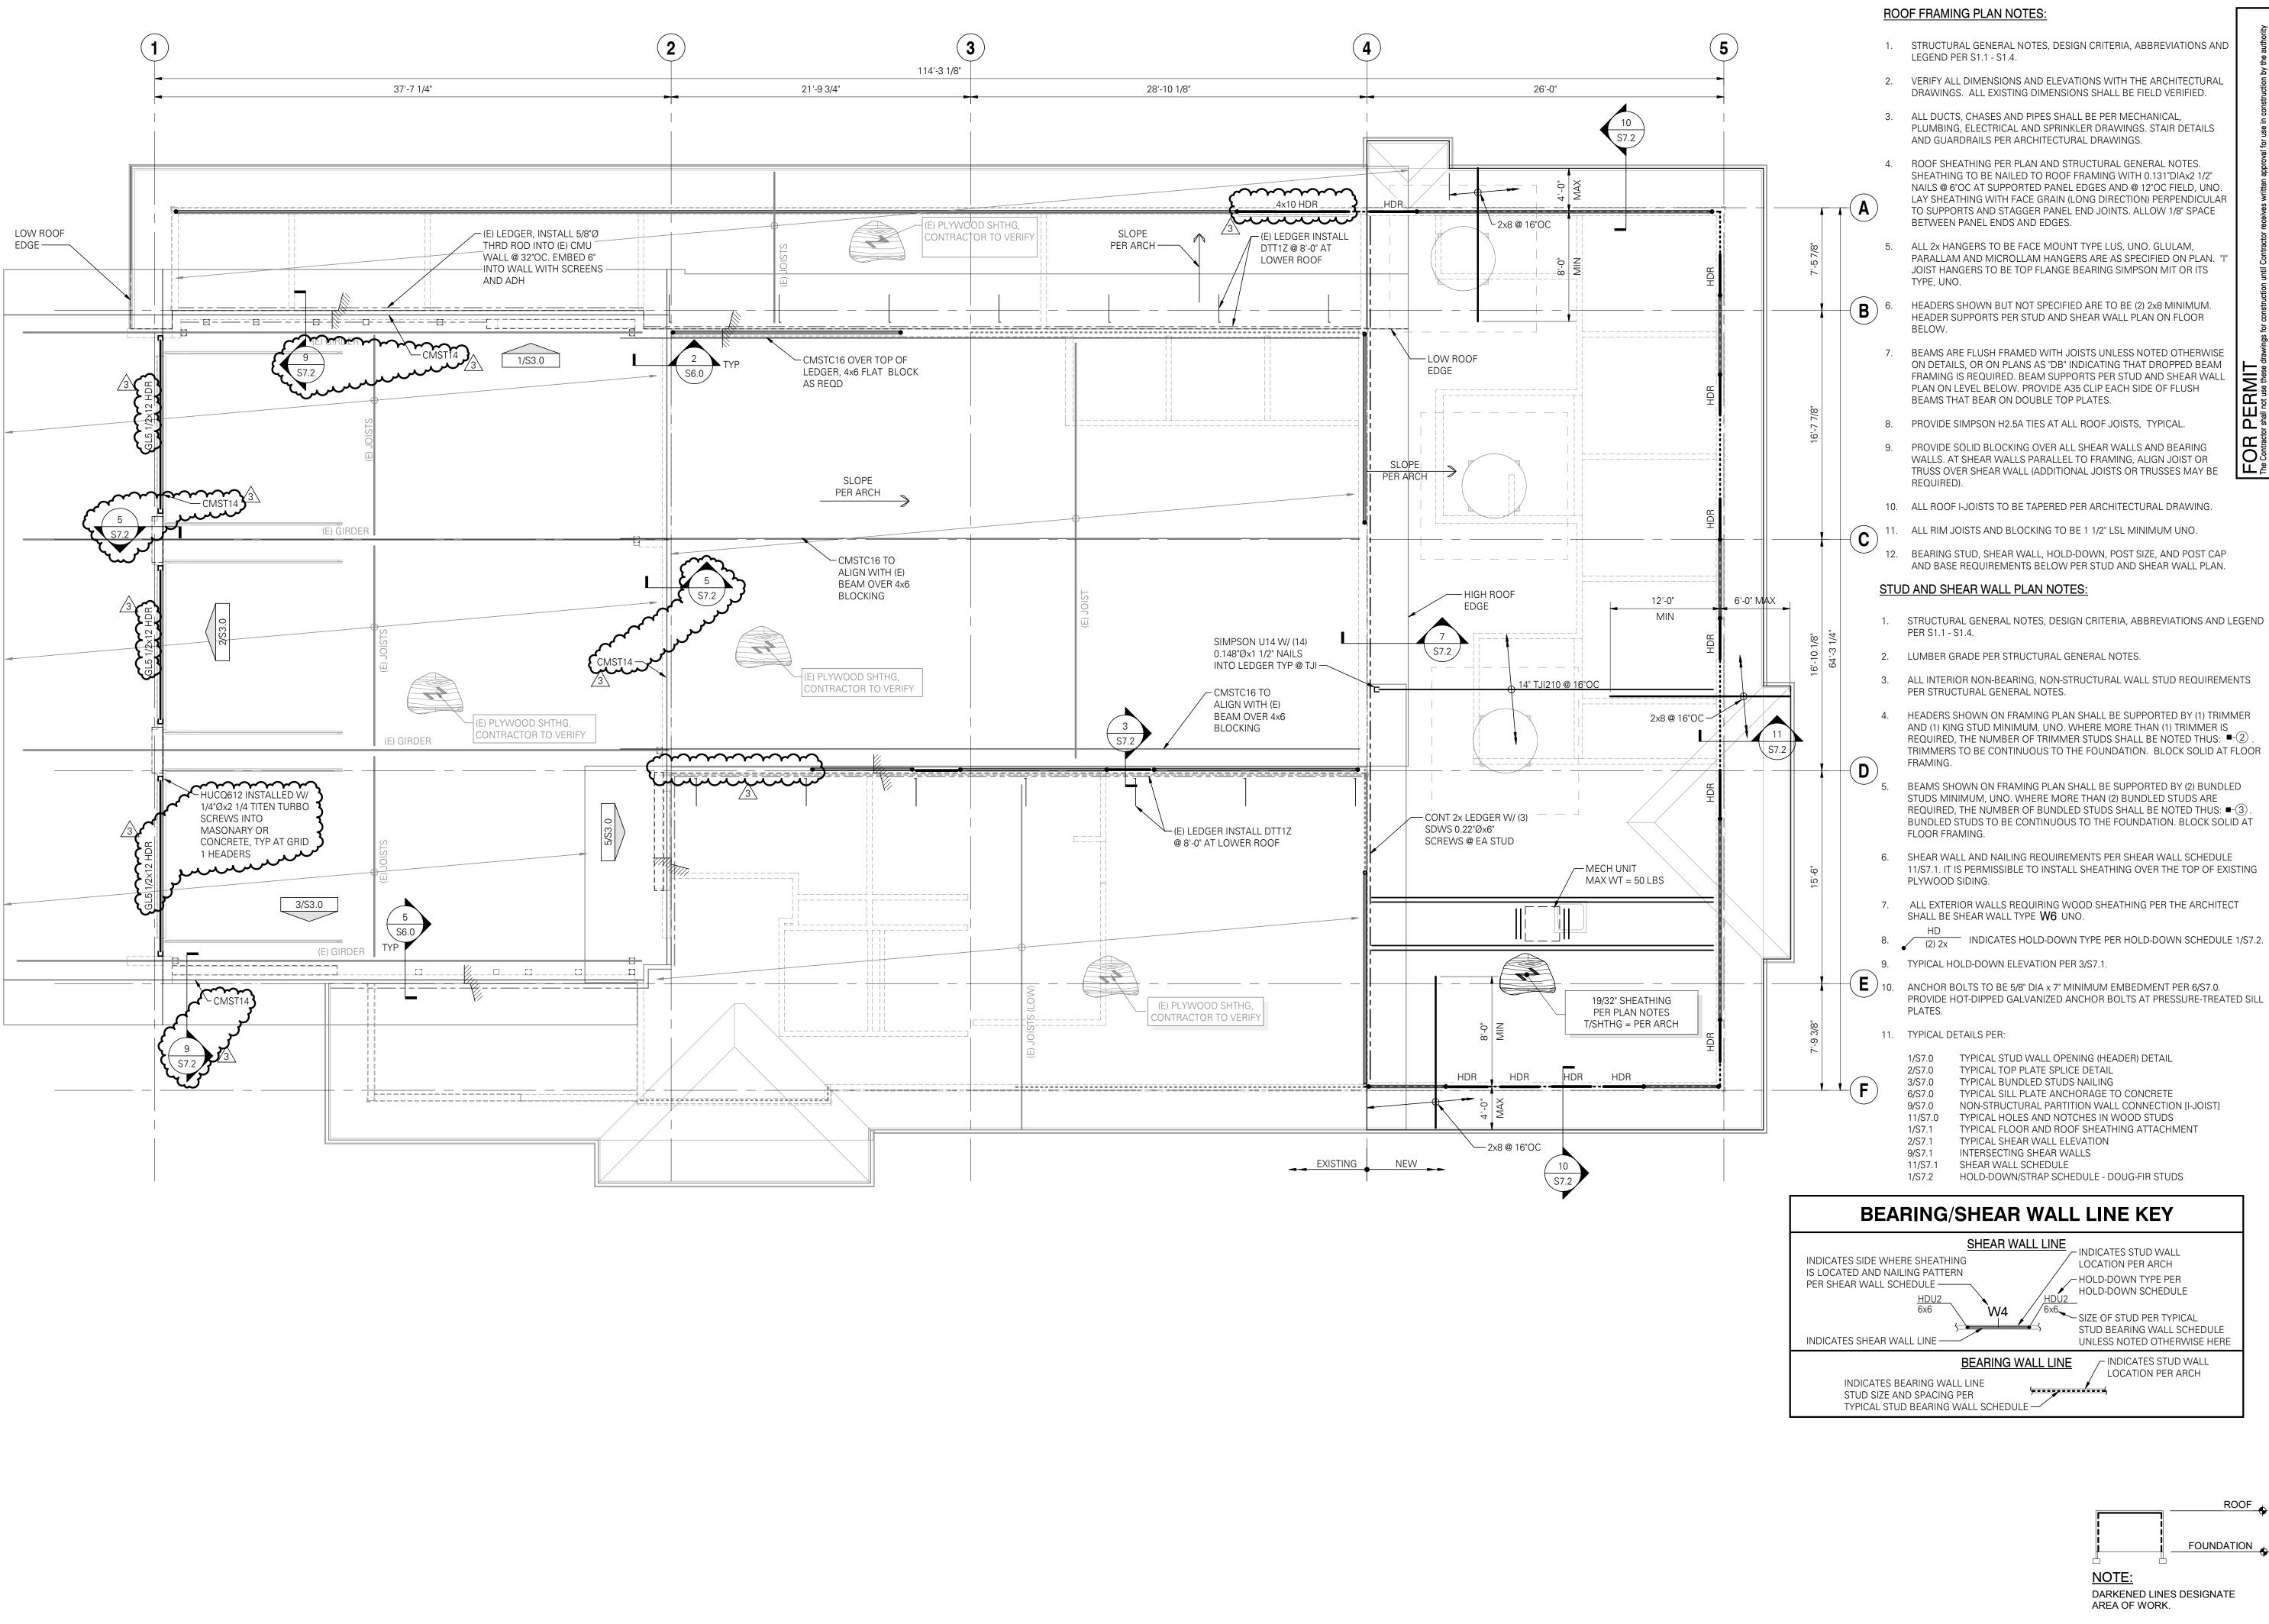

ARCHITECTS

333 S. 4TH STREET COOS BAY, OR 97420 P: 541.269.1166 general@hge1.com www.hge1.com

EXPIRES: 12-31-25

IRE BAY

NORTH $_{\rm II}$ $_{\rm II}$ **EXISTING**

REVISIONS: # DATE DESCRIPTION 3 2/21/2024 ADDENDUM #3

DATE: APRIL-11 SHEET TITLE:

STRUCTURAL - ROOF FRAMING PLAN

S2.2

ROOF FRAMING PLAN

SCALE: 3/16" = 1'-0"

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NOTES

[1] SOME HOLD-DOWN TYPES MAY NOT BE USED ON THIS PROJECT.

[2] TYPICAL HOLD-DOWN DETAILS PER 3/S7.1, 6/S7.1, 10/S7.1. ANCHOR REINFORCEMENT REQUIRED AT STEMWALLS.

[3] PROVIDE PANEL EDGE NAILING PER SHEAR WALL SCHEDULE AT HOLD-DOWN STUDS/POSTS.

[4] BASED ON MINIMUM f'c = 3000 PSI CONCRETE.

[5] STEMWALLS SHALL BE 8" WIDE x 18" TALL MINIMUM.

[6] CAST-IN-PLACE (CIP) TYPE THREADED RODS AT HOLD-DOWNS SHALL HAVE TWO HEX HEAD NUTS WITH OVERSIZED WASHERS.

[7] INCLUDES 1.6 LOAD DURATION INCREASE FOR WOOD.

[8] BASED ON 11 7/8" DEEP FLOOR JOIST.


[9] TOTAL NAILS SPECIFIED, USE HALF THE NAILS AT THE STUDS ABOVE AND BELOW LEVEL BEING CONNECTED.

[10] AT PRESSURE TREATED SILLS, USE HOT DIPPED GALVANIZED

[11] POST INSTALLED HOLD-DOWN OPTIONS MAY BE AVAILABLE AT SOME CONDITIONS. CONTACT ENGINEER OF RECORD PRIOR TO CONSTRUCTION.

[12] NAIL LAMINATE MULTIPLE 2x STUDS WITH PLATE NAILING PER SHEAR WALL SCHEDULE.

[13] STUD WALLS SHALL BE 2x6, CENTER HOLD-DOWN IN STUD WALL.

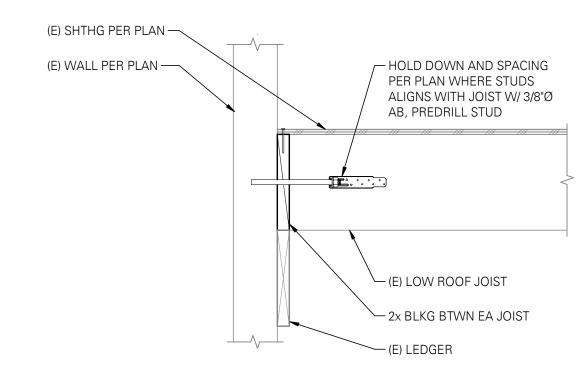

HOLD DOWN AT WOOD WALL AND (E) LOW ROOF PARALLEL TO JOIST

HOLD-DOWN/STRAP SCHEDULE - DOUG-FIR STUDS

NAILS, SCREWS

OR BOLTS

(6) SDS1/4x2 1/2

HOLD-DOWN/STRAP SCHEDULE - DOUG-FIR STUDS

ANCHOR [4]

CAPACITY

3.1k

STEMWALL [5]

EMBED

10"

CIP [6, 13]

CONCRETE EMBEDMENT/CAPACITY

EMBED

CIP [6]

CAPACITY

3.1k

[1, 2, 7, 11] ── INDICATES FOOTNOTES

DIAMETER

[10]

5/8"Ø

NUMBER OF


STUDS/POST


[3, 12]


(2) 2x

TYPE

HDU2

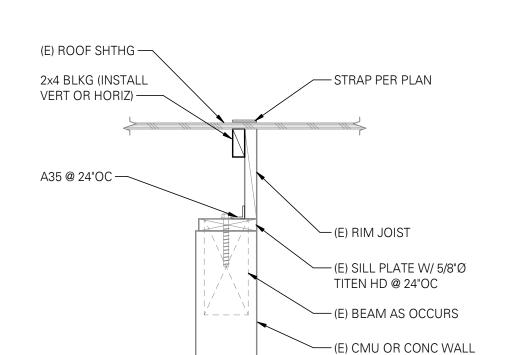


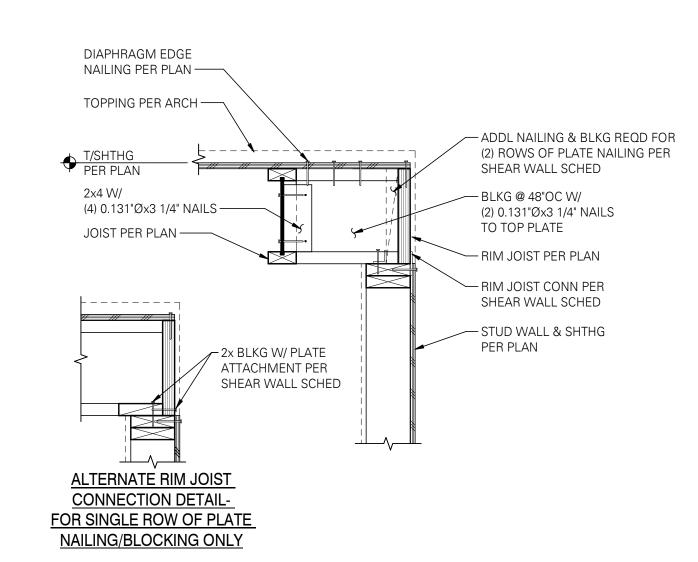


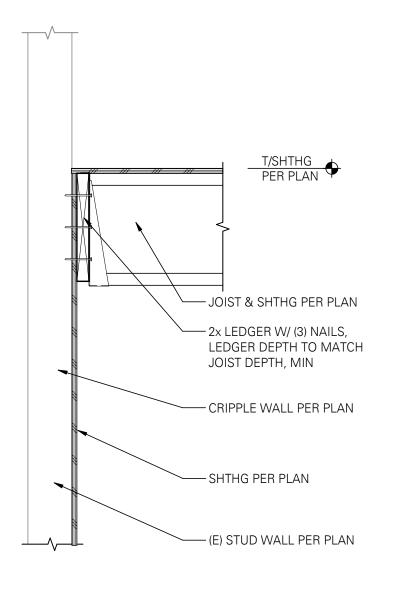


EXISTING MASONARY AT JOIST PARALLEL

EXTERIOR WALL PARALLEL TO FLOOR JOISTS

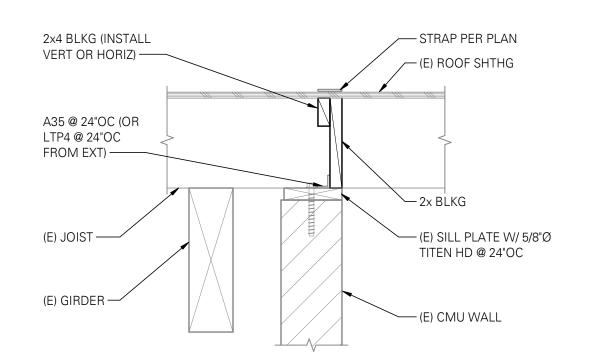

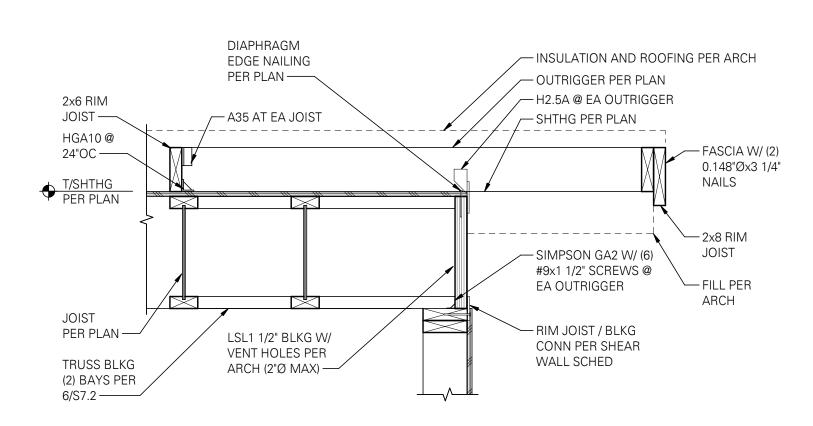

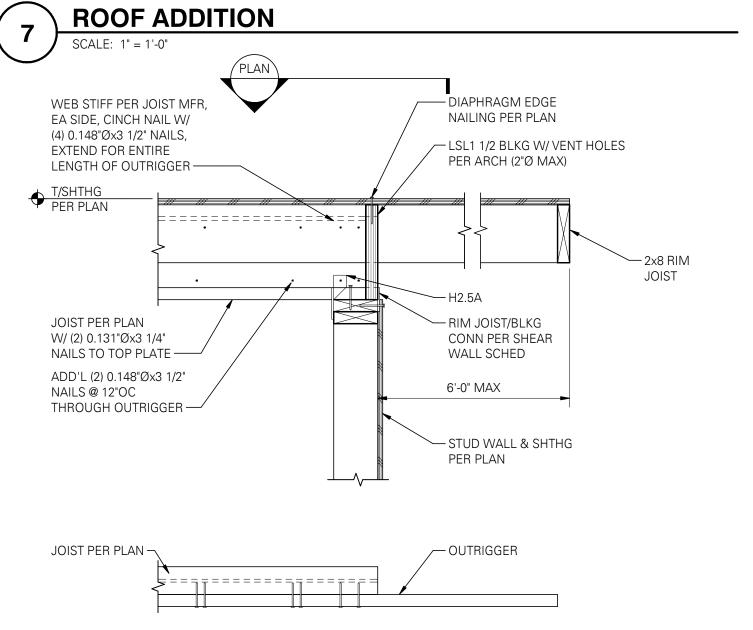

EXTERIOR WALL PERPENDICULAR TO ROOF JOIST WITH OVERHANG - NEW ADDITION

<u>PLAN</u>

FASCIA TO RAFTER CONNECTION

EXISTING MASONARY AT JOIST PARALLEL

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S7.2

ARCHITECTS

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EXPIRES: 12-31-25

ANT

IRE

BAY

NORTH

DATE DESCRIPTION

3 2/21/2024 ADDENDUM #3

APRIL-1

EXISTING

REVISIONS:

DATE:

SHEET TITLE:

DETAILS

STRUCTURAL -**WOOD FRAMING**